
# CHS.NB.1038

DAVIS SQUARE


250 Elm Street Somerville, MA 02144

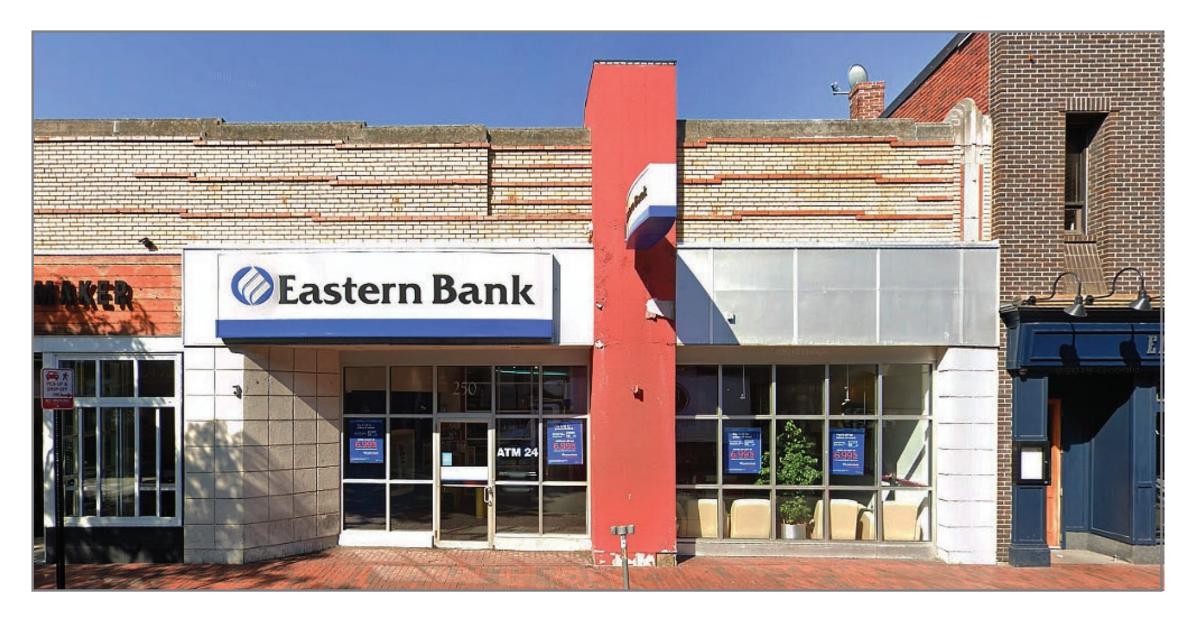



# **REVISION NOTES:**


03.23.22	AC	Updated elevation.
03.28.22	JM	Added A Second Option for E02
04.05.22	AC	Revised as Noted.
05 10 22	۵C	Added Option 1 & 2

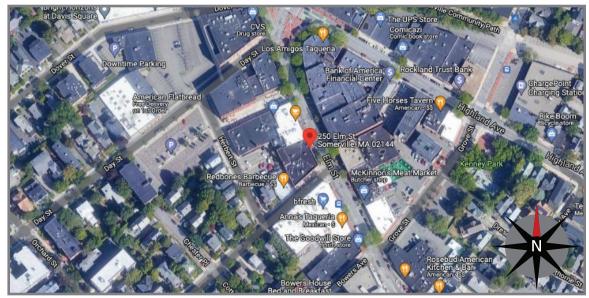

**B99188** 



# **Aerial Plan**

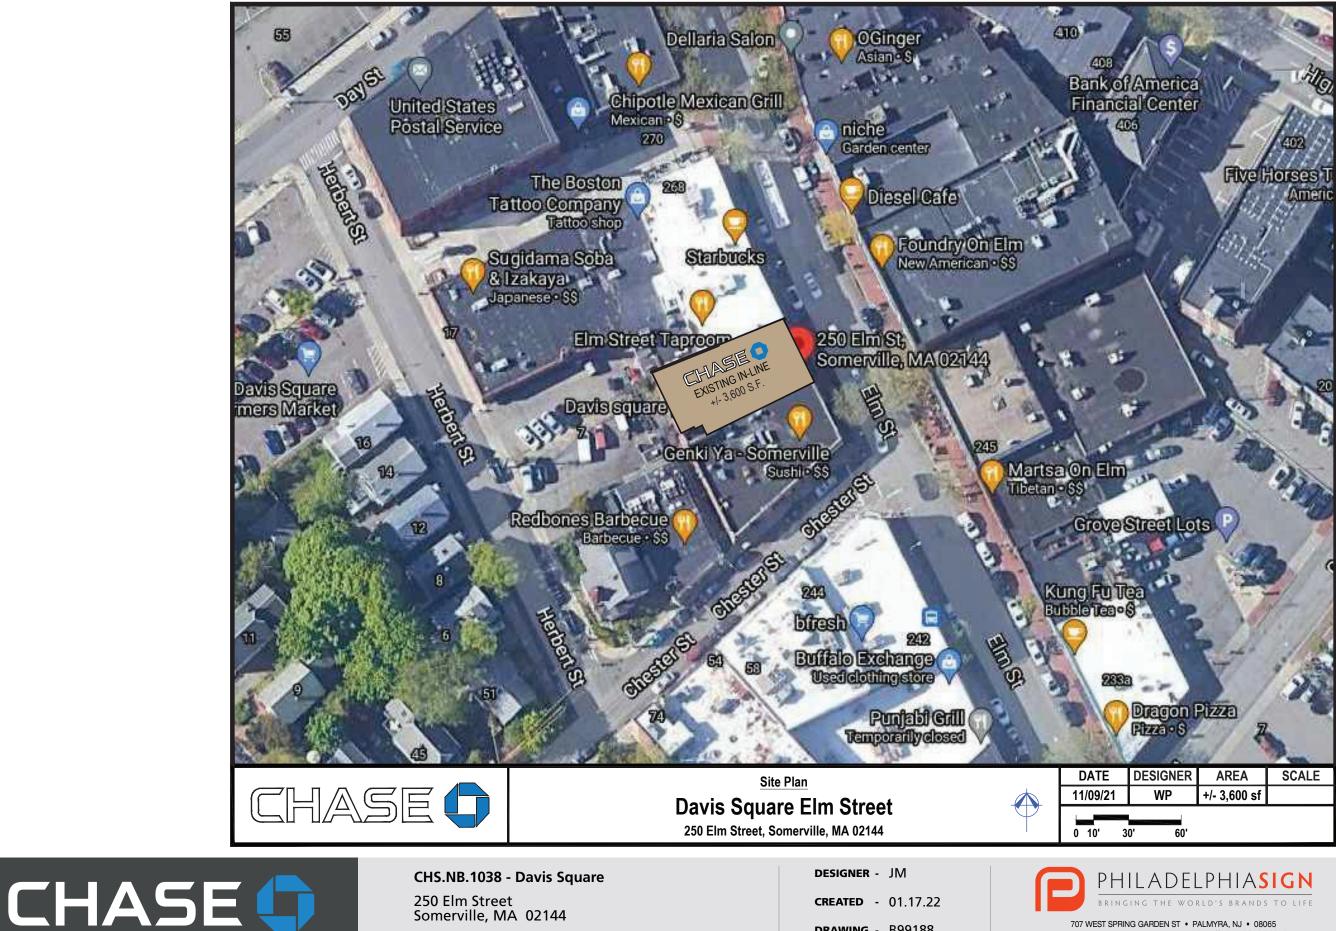


250 Elm Street Somerville, MA 02144

**DRAWING** - B99188

707 WEST SPRING GARDEN ST • PALMYRA, NJ • 08065 P: 856-829-1460 • F: 856-829-8549 • WEB: http://www.philadelphiasign.com

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# Site Plan

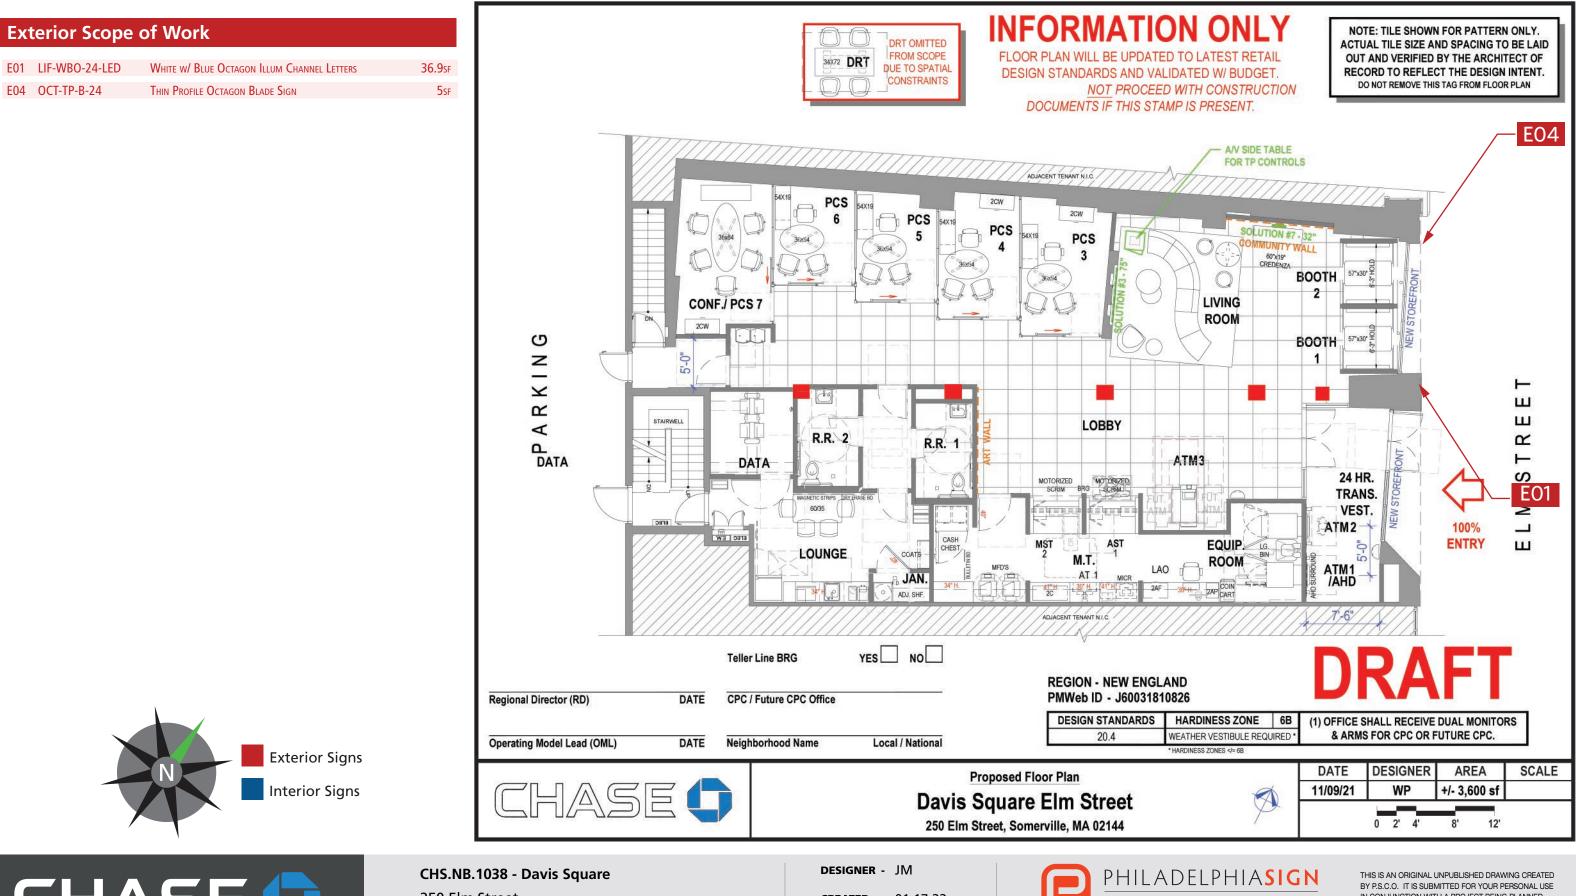

# CHASE

250 Elm Street Somerville, MA 02144


**CREATED** - 01.17.22

**DRAWING** - B99188



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# E01 - LIF-WBO-24-LED

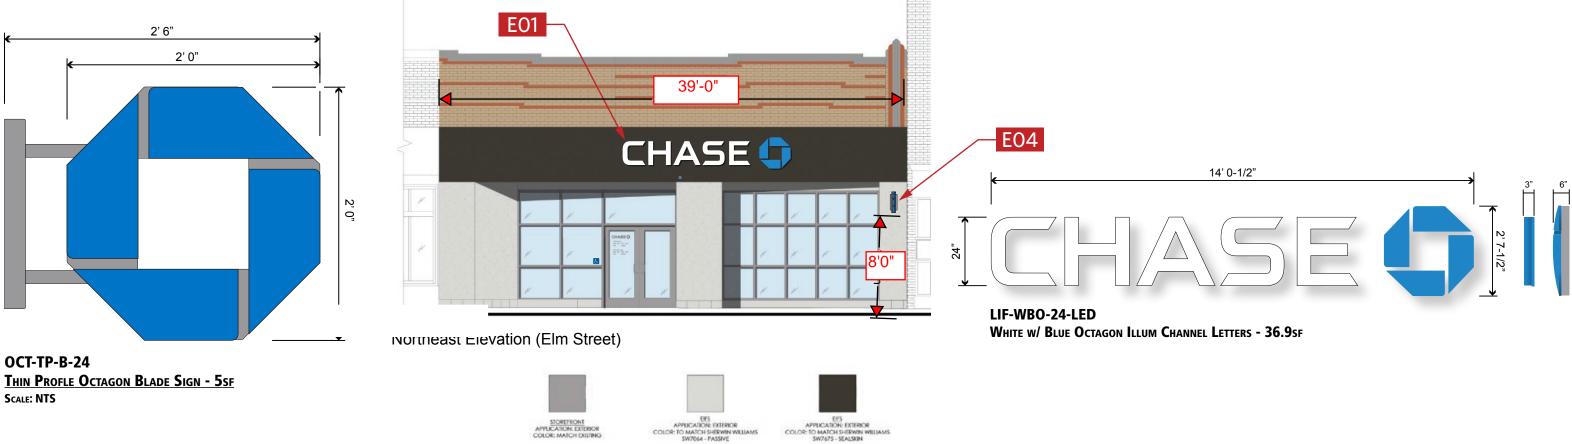

			Max Sign Area		Max # allowed		Min. Height		Max Height		Max width of fascia		Max Projection	
Zoning	Sign #	Sign Type	Allowed	Proposed	Allowed	Proposed	Allowed	Proposed	Allowed	Proposed	Allowed	Proposed	Allowed	Proposed
CBD (Central	E01-LIF	Illuminated					1'-0"	2'-7 1/2"	4'-0"	2'-7 1/2"	90%	35%	6"	6"
		Channel letter wall sign	40sq ft	36.9 sq ft	1	1	1-0	2-1 112	4-0	2-1 112	30 /6	5576	Ů	ľ

Zoning	Sign #	Sign Type	Max Sig	gn Area	Max #	allowed	Max Width	Blade Sign	Max He	eight	Max Thicknes	ss Blade Sign	Clearance of	over Sidewalk	Max Projection	from Façade
			Allowed	Proposed	Allowed	Proposed	Allowed	Proposed	Allowed	Proposed	Allowed	Proposed	Allowed	Proposed	Allowed	Proposed
CBD (Central								01.61								2' 6"
Business	E04-OCT-	Illuminated					4'-0"	2'-6"	3'-0"	2'-0"	6"	4 1/2"	8'-0"	8'-0"	4'-0"	2'-6"
District)	TP-B-24	Blade Sign	6sq ft	4 sq ft	1	1										

# 

CHS.NB.1038 - Davis Square

250 Elm Street Somerville, MA 02144


designer - JM

**CREATED** - 01.17.22 DRAWING - B99188



# E04 - OCT-TP-B-24

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5. Full Size Drilling Template Furnished With Sign.

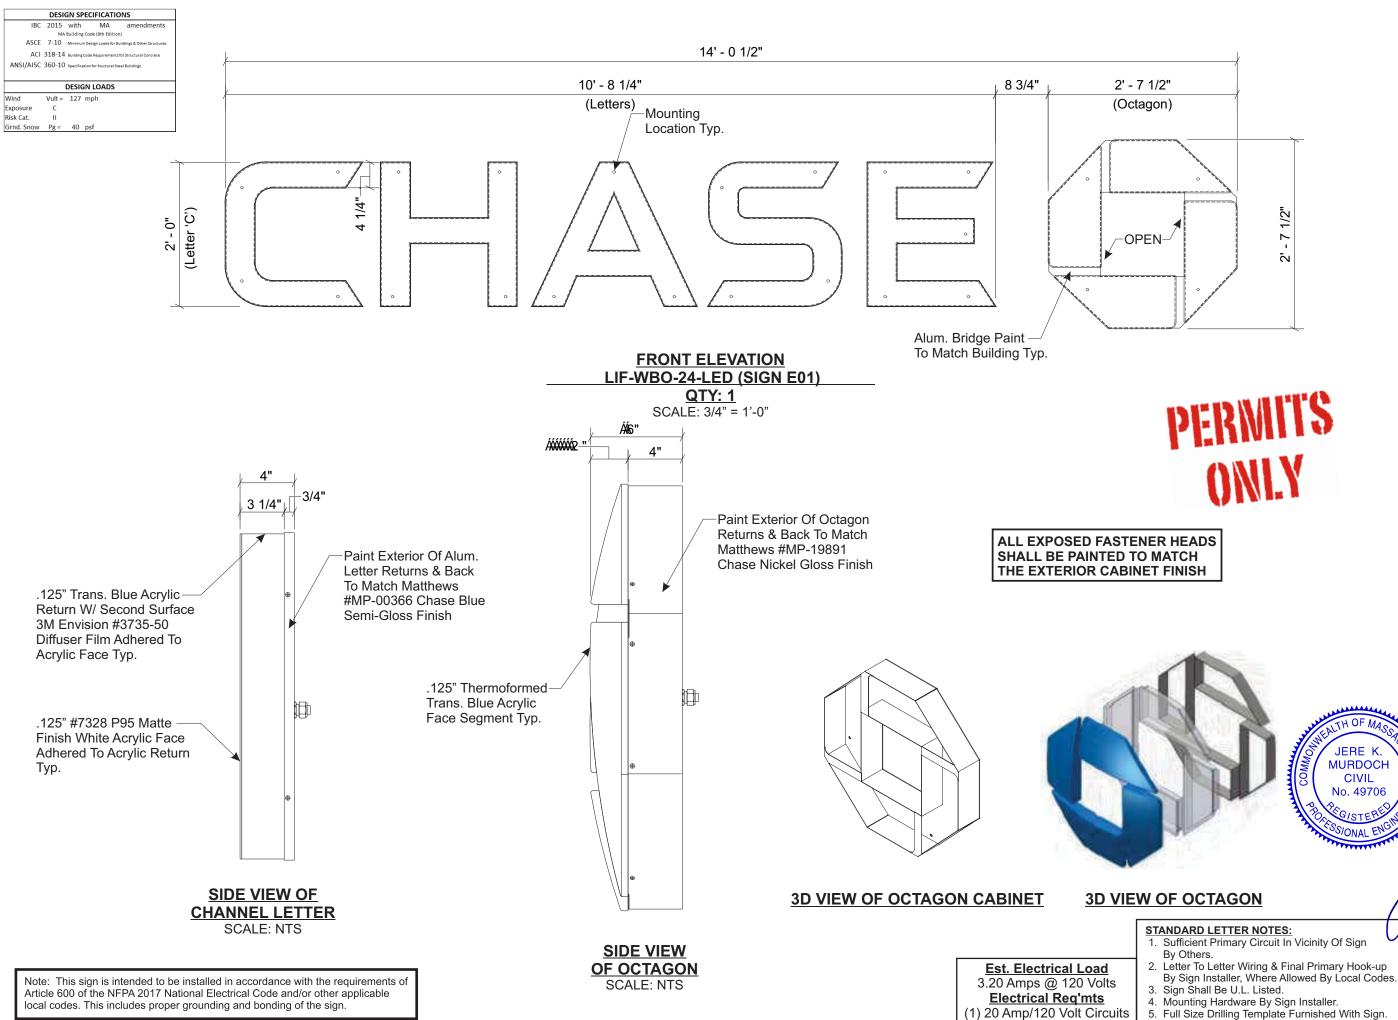

# PHILADELPHIASIGN

BRINGING THE WORLD'S BRANDS TO LIFE

707 West Spring Garden Street Palmyra, New Jersey 08065

Phone: 856.829.1460 Fax: 856.829.8549 www.philadelphiasign.com

**CUSTOMER:** 

CHASE

JOB NUMBER:

S107857/CHS.NB.1038

SIGN TYPE: SITE SIGNAGE

LOCATION:

250 Elm St Somerville MA 02144

DATE:

5/27/2022

DRAWN BY:

DRC

**REVISION:** Number: Date

By:

SHEET: 1 OF 4 ENG DEPT

DWG NUMBER: B-94271

ENGINEER SEAL:

TH OF M

JERE K.

**MURDOCH** 


CIVIL No. 49706


VONAL EN

MURDOCH ENGINEERING 2399 A-2 NJ-34 108736 3 570-82 mon el i 8/1/2022

Jere Murdoch, PE Professional Engineer MA PE Lic. #49706


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LEDs: (121) 7100K White Sloan Prism #701269-7WSJ1-MB (40) Blue Sloan Prism #701269-BLSJ1-MB Power Supply: (4) Sloan Prism 60C2 60W #701507-60C2 @ 0.8A Total Load: 3.2A @120VAC Circuits: (1) 20 Amp Required

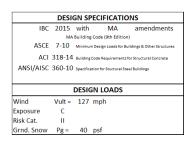**ALL PRIMARY & SECONDARY** WIRING MUST BE GROUNDED PER ALL APPLICABLE UL & **NEC GUIDELINES** 

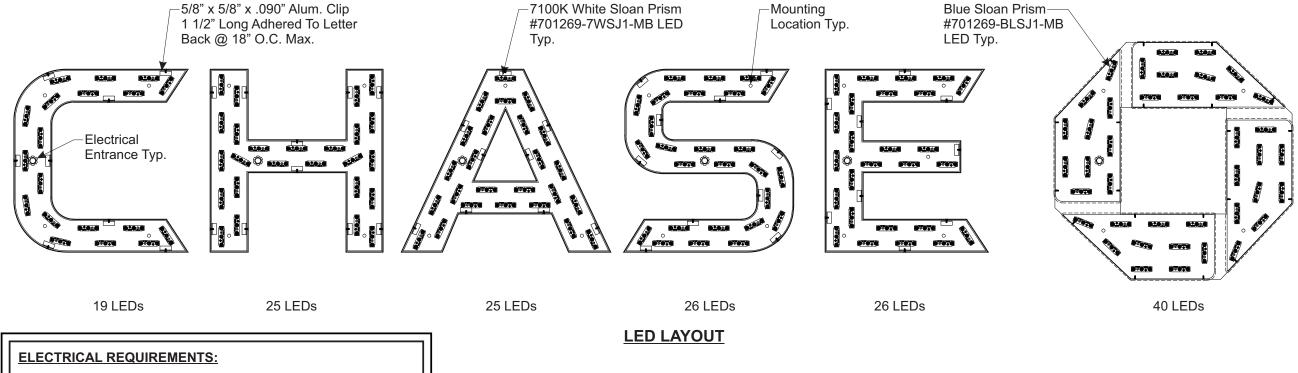

### WIRING DIAGRAM FOR REMOTE, NON-PARAPET WALL INSTALLATION

Note: This sign is intended to be installed in accordance with the requirements of Article 600 of the NFPA 2017 National Electrical Code and/or other applicable local codes. This includes proper grounding and bonding of the sign.
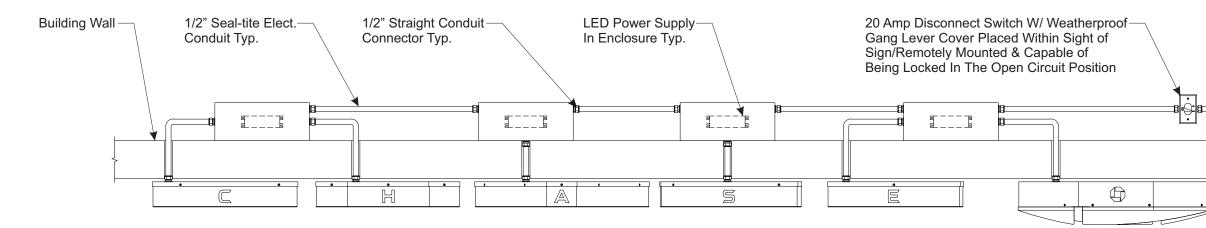
# RMITS ONLY

To Primary

TH OF MA

JERE K.

**MURDOCH** 

CIVIL No. 49706

VSTERE

VONAL EN

Circuit



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CUSTOMER:

CHASE

JOB NUMBER:

S107857/CHS.NB.1038

SIGN TYPE: SITE SIGNAGE

LOCATION:

250 Elm St Somerville, MA02144

DATE:

5/27/2022

DRAWN BY:

DRC

**REVISION:** Number: Date

By:

SHEET: 2 OF 4 ENG DEPT


DWG NUMBER: B-94271

ENGINEER SEAL:

MURDOCH ENGINEERING 2399 A-2 NJ-34 MANASQUAN, NJ 087 70-8215 x0 1000 M8/1/2022 eU) Jere Murdoch, PE essional Engineer MA PE Lic. #49706

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Article 600 of the NFPA 2017 National Electrical Code and/or other applicable local codes. This includes proper grounding and bonding of the sign.

SEE FOLLOWING PAGE FOR VARIOUS INSTALLATION METHODS

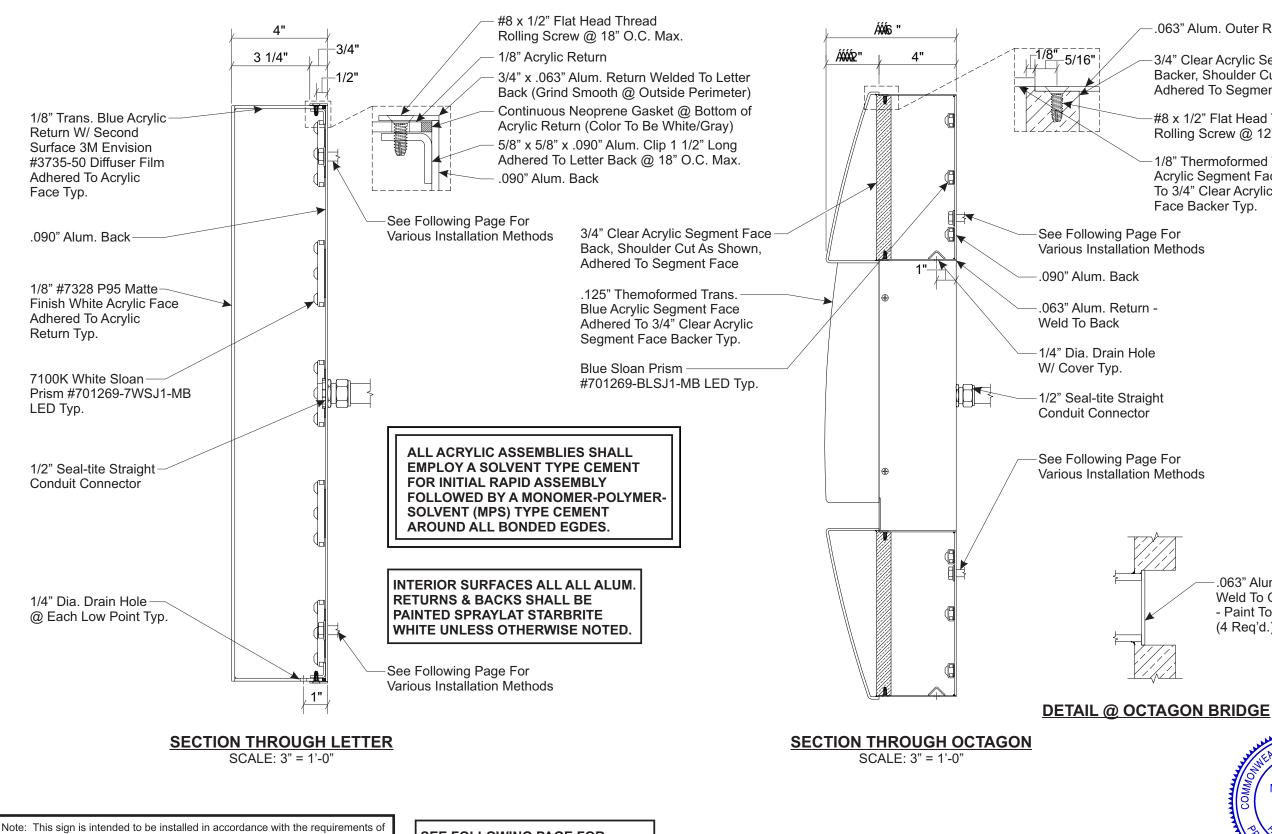

.063" Alum. Outer Return

3/4" Clear Acrylic Segment Face Backer, Shoulder Cut As Shown, Adhered To Segment Face

#8 x 1/2" Flat Head Thread Rolling Screw @ 12" O.C. Max.

1/8" Thermoformed Trans. Blue Acrylic Segment Face Adhered To 3/4" Clear Acrylic Segment Face Backer Typ.

.063" Alum. Bridge Plate -Weld To Octagon Returns - Paint To Match Building (4 Req'd.)





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CUSTOMER:

CHASE

JOB NUMBER:

S107857/CHS.NB.1038

SIGN TYPE: SITE SIGNAGE

LOCATION:

250 Elm St Somerville, MA 02144

DATE:

5/27/2022

DRAWN BY:

DRC

**REVISION:** Number: Date

By:


SHEET: 3 OF 4 ENG DEPT

DWG NUMBER: B-94271

**ENGINEER SEAL:** 

MURDOCH ENGINEERING 2399 A-2 NJ-34 MANASQUAN, NJ 03 (973) 570-8215 x0 1000 Mg/1/2022 eU / Jere Murdoch, PE essional Engineer MA PE Lic. #49706

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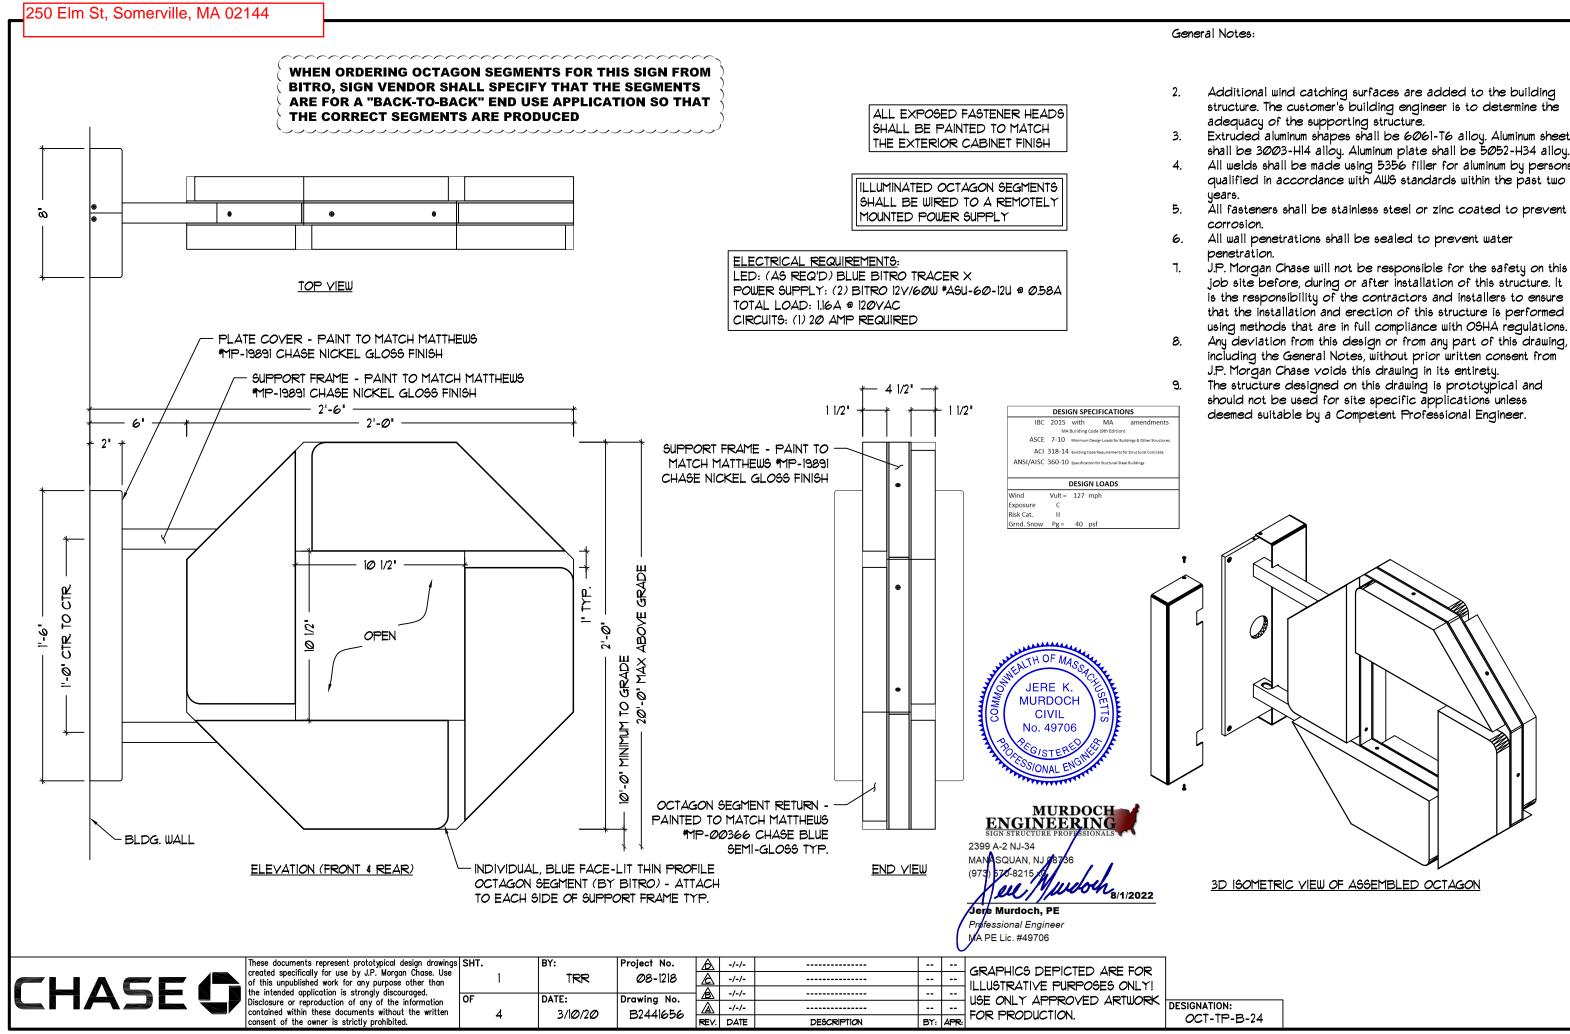


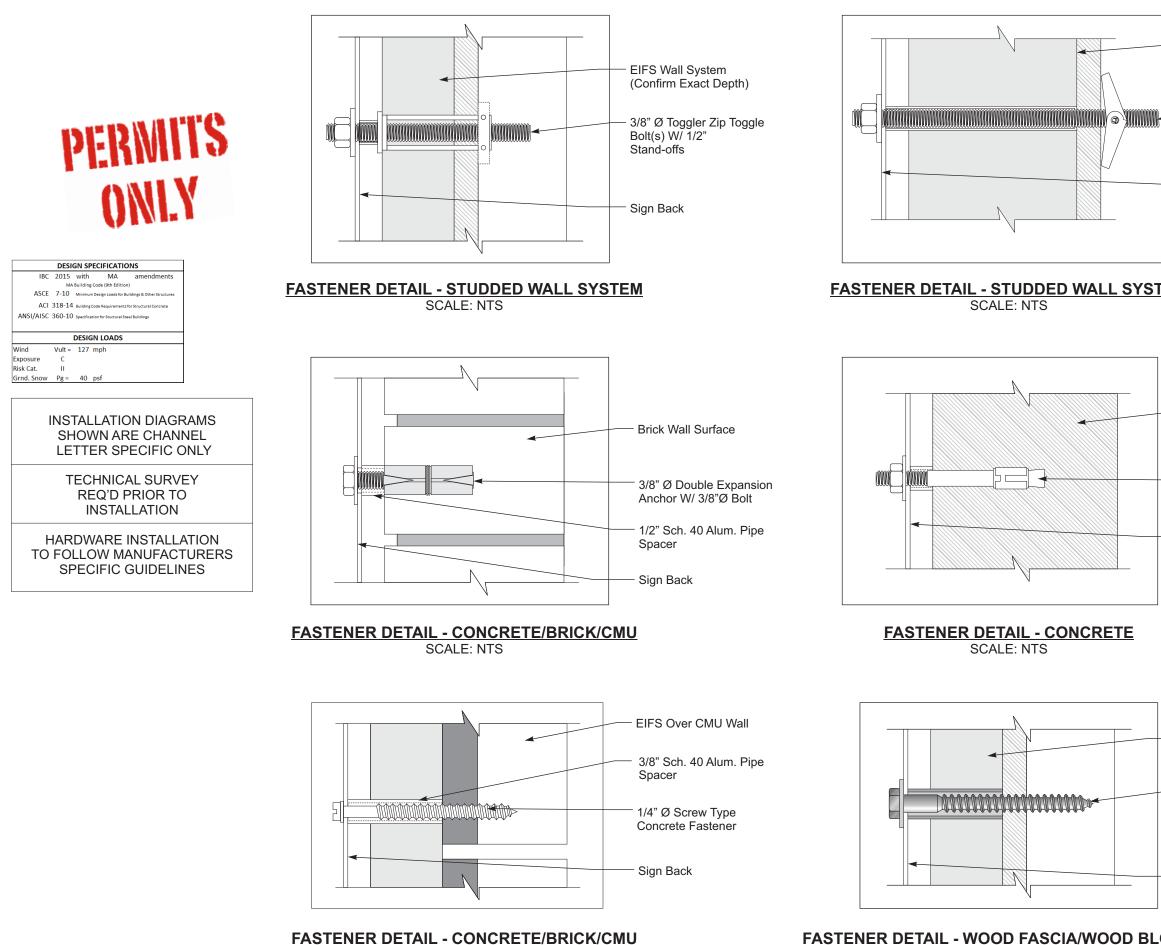SCALE: NTS

Note: This sign is intended to be installed in accordance with the requirements of Article 600 of the NFPA 2017 National Electrical Code and/or other applicable local codes. This includes proper grounding and bonding of the sign.

FASTENER DETAIL - WOOD FASCIA/WOOD BL SCALE: NTS

EIFS Wall W/ Stucco And Insulation Over Sheathing								
<ul> <li>3/8" Ø All Thread W/</li> <li>Toggle Wing</li> <li>W/ 1/2" Stand-offs</li> </ul>	PHILADELPHIASIGN BRINGING THE WORLD'S BRANDS TO LIFE							
	707 West Spring Garden Street Palmyra, New Jersey 08065							
Sign Back	Phone: 856.829.1460 Fax: 856.829.8549 www.philadelphiasign.com							
	CUSTOMER: CHASE							
<u>EM</u>	JOB NUMBER: S107857/CHS.NB.1038							
	SIGN TYPE: SITE SIGNAGE							
Concrete Wall	LOCATION: 250 Elm St Somerville, MA 02144							
—— 3/8" Ø X Expansion	DATE: <b>5/27/2022</b>							
Anchor W/ 1/2" Alum. Spacer	DRAWN BY: DRC							
—— Sign Back	<b>REVISION:</b> Number: Date: By:							
	SHEET: ENG DEPT 4 OF 4							
	DWG NUMBER: B-94271							
	ENGINEER SEAL:							
— EIFS Wall System								
— 3/8" Ø Lag Bolt Into	MURDOCH							
Existing Plywood	ENGINEERING SIGN STRUCTURE PROFESSIONALS							
(3/4" Min. Thickness Plywood Req'd.)	2399 A-2 NJ-34 MANASQUAN, NJ 08736 (973 970-8215 x9							
- Sign Back	- Mul // Mul Olasi Jere Murdoch, PE Professional Engineer							
OCKING	MA PE Lic. #49706 This is an original unpublished drawing created by psco. It is submitted for your personal use in conjunction with a project being planned for you by psco. It is not to be shown to anyone outside your organization nor is it to be used, copied, reproduced, or exhibited in any fashion.							



- Additional wind catching surfaces are added to the building structure. The customer's building engineer is to determine the
- shall be 3003-HI4 alloy. Aluminum plate shall be 5052-H34 alloy All welds shall be made using 5356 filler for aluminum by persons qualified in accordance with AWS standards within the past two
- All fasteners shall be stainless steel or zinc coated to prevent
- job site before, during or after installation of this structure. It is the responsibility of the contractors and installers to ensure that the installation and erection of this structure is performed using methods that are in full compliance with OSHA regulations. Any deviation from this design or from any part of this drawing,
- The structure designed on this drawing is prototypical and

